Building Data Summary				
Project ID:	******			
Location:	*******			
Scope of Work:	Concrete			
Date:				

em #	Ref. Sheet #	Item Description	Unit	Quantity	Wastage	Quantity w/ Wastage	Unit Materi Cost	al Total Material Cost	Unit Manhour	Hourly Wage	Unit Labor Cost	Total Labor Cost	Sub Cost	Total Trade Cost
		DIVISION.01 GENERAL REQUIREMENTS												
1		Supervision and Coordination	LS	1	0%	1	\$ -	\$ -	0.000	\$ -	\$ -	\$ -	\$ 8,500.00	
2		Submittals and Shop drawings	LS	1	0%	1	\$ -	\$ -	0.000	\$ -	\$ -	\$ -		
3		Final Cleaning	LS	1	0%	1	\$ -	\$ -	0.000	\$ -	\$ -	\$ -	\$ 2,000.00	
4		Mobilization Costs	LS	1	0%	1	\$ -	\$ -	0.000	\$ -	\$ -	\$ -	\$ 3,800.00	1
5		Temporary Control & Facilities	LS	1	0%	1	\$ -	\$ -	0.000	\$ -	\$ -	\$ -	\$ 2,500.00	
		Subtotal (General Requirement	s)											\$ 16,8
1		DIVISION 02- Site Demolition	1			1						1	I	I
		Basement												-
6		Sawcut & Remove Concrete Slab	SF	136	0%	136	\$ -	\$ -	0.350	\$ 70.00	\$ 24.50	\$ 3,332.00	\$ 3,332.00	†
7		Remove Concrete Beam	LF	8	0%	8	\$ -	\$ -	0.350	\$ 70.00	\$ 24.50		\$ 196.00	1
		First Floor												1
8		Remove Concrete Wall	SF	66	0%	66	\$ -	\$ -	0.350	\$ 70.00	\$ 24.50	\$ 1,617.00	\$ 1,617.00	1
9		Sawcut & Remove Concrete Slab	SF	110	0%	110	\$ -	\$ -	0.350	\$ 70.00	\$ 24.50	\$ 2,695.00	\$ 2,695.00	
	S1.1-S1.4	2nd Floor]
LO		Remove Concrete Beam	LF	15	0%	15	\$ -	\$ -	0.350	\$ 70.00]
1		Sawcut & Remove Concrete Slab	SF	497	0%	497	\$ -	\$ -	0.350	\$ 70.00	\$ 24.50	\$ 12,176.50	\$ 12,176.50	1
]		Roof												1
.2		Sawcut & Remove Concrete Slab	SF	120	0%	120	\$ -	\$ -	0.350	\$ 70.00	\$ 24.50	\$ 2,940.00	\$ 2,940.00	1
		Excavation												1
13		Excavation @ Footing	CY	7.30	5%	8	\$	- \$ -	1.100	\$ 60.00	\$ 66.00		\$ 505.89	
		Subtotal (Finishe	s)			/ %		\$ -				\$ 23,830		\$ 23,8
		DIVISION 03- Concrete			13			× .						
		Foundation			- A	1		.0	-					T
\dashv		Slab			-				40					†
.4		(18" Thick) Reinf. Concrete Slab - 131 SF	CY	7.28	5%	8	\$ 272.2	\$ 2 ,081.08	2.450	\$ 60.00	\$ 147.00	\$ 1,123.67	\$ 3,204.75	-
\dashv		-#8 Bars @ 12" O.C E.W Top & Bottom				A 0		All HAL	_				·	
15		(5" Thick) Reinf. Concrete Slab - 67 SF -#4 Bars @ 18" O.C E.W	CY	1.05	5%	1	\$ 272.2	5 \$ 300.16	2.450	\$ 60.00	\$ 147.00	\$ 162.07	\$ 462.22	
		Wall						Ψ.						-
		(8" Thick) Reinf. Concrete Wall (31 LF,4'H)	CV	2.00	F0/	100	\$ 272.2		2.450	¢ 60.00	ć 447.00	475.40	4 255 05	
16		-#6 Vert. Bar @ 12" O.C	CY	3.08	5%	3	\$ 272.2	\$ 880.46	2.450	\$ 60.00	\$ 147.00	\$ 475.40	\$ 1,355.85	
		-#5 Horiz. Bar @ 12" O.C Basement				-61				_		-		-
-		Wall				50,								+
\dashv		(8" Thick) Reinf. Concrete Wall (61 LF,9'-6"H)												1
17		-#6 Vert. Bar @ 12" O.C	CY	14.38	5%	15	\$ 272.2	5 \$ 4,110.70	2.450	\$ 60.00	\$ 147.00	\$ 2,219.55	\$ 6,330.26	
		-#5 Horiz. Bar @ 12" O.C		2 1.50	3,0	13	2,2.2	.5 0 1,220.70	2.130	00.00	7 177.00	2,213.33	0,550.20	
=	S2.1-S2.4	1st Floor						1						1
\neg		Wall						1						1
\neg		(8" Thick) Reinf. Concrete Wall (30 LF,12'H)												1
18		-#5 Vert. Bar @ 12" O.C	CY	8.94	5%	9	\$ 272.2	2,555.61	2.450	\$ 60.00	\$ 147.00	\$ 1,379.89	\$ 3,935.50	
		-#4 Horiz. Bar @ 12" O.C]
		2nd Floor												1
		Wall												1
		(8" Thick) Reinf. Concrete Wall (30 LF,12'H)						1.		T		Ι.		
.9		-#5 Vert. Bar @ 12" O.C	CY	8.94	5%	9	\$ 272.2	2,555.61	2.450	\$ 60.00	\$ 147.00	\$ 1,379.89	\$ 3,935.50	
		-#4 Horiz. Bar @ 12" O.C												1
		Roof												4
		Wall	+			-		+				-		1
		(8" Thick) Reinf. Concrete Wall (31 LF,4'H)	CV.	2.00	50/	_								
.0		-#5 Vert. Bar @ 12" O.C	CY	3.08	5%	3	\$ 272.2	15 \$ 880.46	2.450	\$ 60.00	\$ 147.00	\$ 475.40	\$ 1,355.85	
\dashv		-#4 Horiz. Bar @ 12" O.C Subtotal (Finishe	c)					\$ 13,364				\$ 7,216		\$ 20,
		Subtotal (Finishe	5)					\$ 13,364				→ /,216		y 20,
													PROJECTED COST	\$ 61,2
												INSURANCE		\$ 61,
												CONTINGENCY	5%	\$ 3,
												AD AND PROFIT	15%	\$ 3,1
												MATERIAL PRICE	2%	\$ 1,224
												TAX	0%	\$

SCALE: 3/16" = 1'-0" DEMO - FOUNDATION PLAN

Sawcut & Remove Concrete Slab

109.8 SQ FT

DEMOLITION PLAN NOTES

- A. VERIFY ALL DIMENSIONS, ELEVATIONS, SLOPES, ETC., w/ ARCH'L. PRIOR TO CONSTRUCTION. RESOLVE DISCREPANCIES WITH ARCHITECT.
- B. THESE PLANS ASSUME ALL AS BUILT DRAWINGS MATCH CURRENT CONDITIONS. IF CONDITIONS EXIST WHICH DIFFER FROM FRAMING SHOWN IT SHALL BE BROUGHT TO THE ATTENTION OF THE ENGINEER OF RECORD THROUGH THE ARCHITECT PRIOR TO DEMOL
- D. PROTECT STRUCTURE FROM UNIECESSARY DAMAGE.
- E. DEMOLISH ROOF/FLOOR DECK BACK TO EXISTING FRAMING WHERE SHOWN.

LEGEND	
SYMBOL	DESCRIPTION
	EXISTING TO BE REMOVED
	EXISTING TO REMAIN
	EXISTING SLAB TO BE REMOVED
\(\tau_{\u}\u}\tau_{\tau_{\tau_{\tau_{\tau_{\tau_{\u}\tau_{\tau_{\u}\tau_{\tau_{\tau_{\tau_{\tau\u}\ta}\ta\tau_{\tau\ta\tau\ta\ta\ta\ta\ta\ta\ta\ta\ta\ta\ta\ta\ta\	EXISTING WALL TO BE REMOVED

DEMOLITION PLAN KEYNOTES

- DEMO (E) SLAB
- (D) NOT USED
- (E) CONCRETE BEAM
- (E) CONCRETE WALL
- OB) DO NOT DAMAGE OR CUT (E) SLAB REBAR BEND REBAR IN (N) WALL PER DETAIL 215/952

AHJ STAMP



Raising Cane's Restaurant #C1110 4345 University Way NE. Seattle, WA 98105 Prototype NTV-B



38 EXECUTIVE PARK, SUITE 310 IRVINE, CA 92614 CONTACT: JEFF LIEDERMAN (949) 430-7051 JLIEDERMAN@PMDGINC.COM



Prototype:		NTV
Prototype Issue	Date:	-
Design Bulletin	Updates:	-
Date Issued:	Bulletin Number:	
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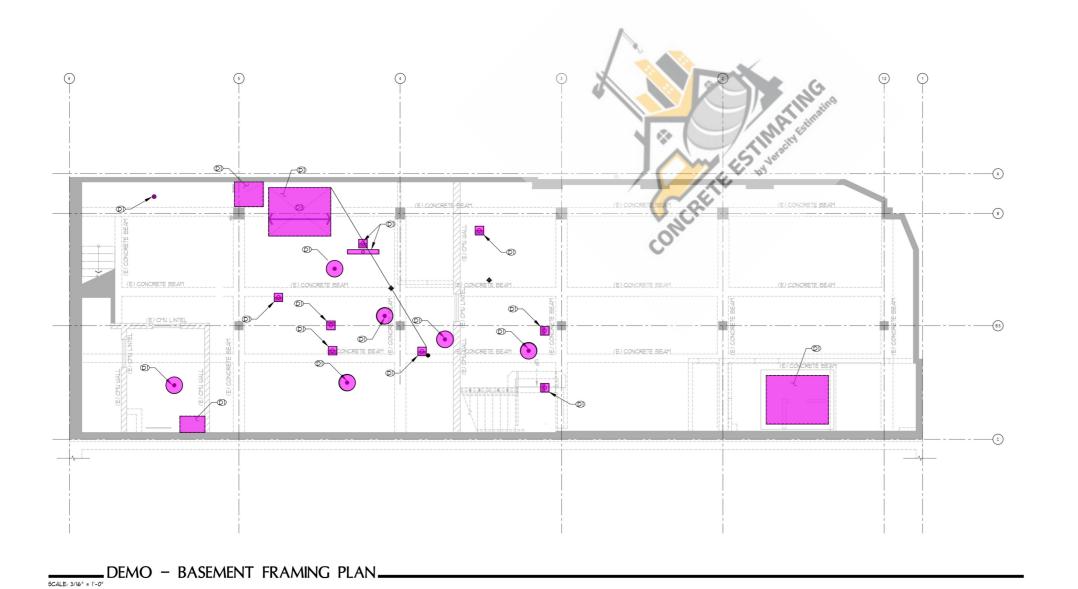
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RI	EVISIONS:	
	DATE	SUBMITTAL
1	12-14-2023	1st Bldg. Dept. Submittal
2	03-15-2024	2ND PERMIT SUBMITTAL
3	05-01-2024	2ND PERMIT RESPONSE
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Sheet Title: DEMO - FO PL	UNDATION 5
Date:	12.14.2023
Project Number:	RAC23028.0
Drawn By:	L.L., N.R.
Check By:	C.B.
Sheet Number:	UNDATION - S



135.6 SQ FT 7.4 FT



DEMOLITION PLAN NOTES

- A. VERIFY ALL DIMENSIONS, ELEVATIONS, SLOPES, ETC., w/ ARCH'L. PRIOR TO CONSTRUCTION. RESOLVE DISCREPANCIES WITH ARCHITECT.
- B. THESE PLANS ASSUME ALL AS BUILT DRAWINGS MATCH CURRENT CONDITIONS. IF CONDITIONS EXIST WHICH DIFFER FROM FRAMING SHOWN IT SHALL BE BROUGHT TO THE ATTENTION OF THE ENGINEER OF RECORD THROUGH THE ARCHITECT PRIOR TO DEMOL
- D. PROTECT STRUCTURE FROM UNIECESSARY DAMAGE.
- E. DEMOLISH ROOF/FLOOR DECK BACK TO EXISTING FRAMING WHERE SHOWN.
- F. PLANS DENOTE DEMOLITION BELOW FRAMING LEVEL SHOWN.

LEGEND	
SYMBOL	DESCRIPTION
	EXISTING TO BE REMOVED
	EXISTING TO REMAIN
	EXISTING SLAB TO BE REMOVED
72777277727772772772	EXISTING WALL TO BE REMOVED

DEMOLITION PLAN KEYNOTES

- DEMO (E) SLAB
- (D) NOT USED
- (E) CONCRETE BEAM
- (E) CONCRETE WALL
- (DB) DO NOT DAMAGE OR CUT (E) SLAB REBAR BEND REBAR IN (N) WALL PER DETAIL 215/952

AHJ STAMP



Raising Cane's Restaurant #C1110 4345 University Way NE. Seattle, WA 98105 Prototype NTV-B

Architectural

38 EXECUTIVE PARK, SUITE 310 IRVINE, CA 92614 CONTACT: JEFF LIEDERMAN (949) 430-7051 JLIEDERMAN@PMDGINC.COM



Prototype :	NTV	
Prototype Issue	Date:	-
Design Bulletin	-	
Date Issued:	Bulletin Number:	
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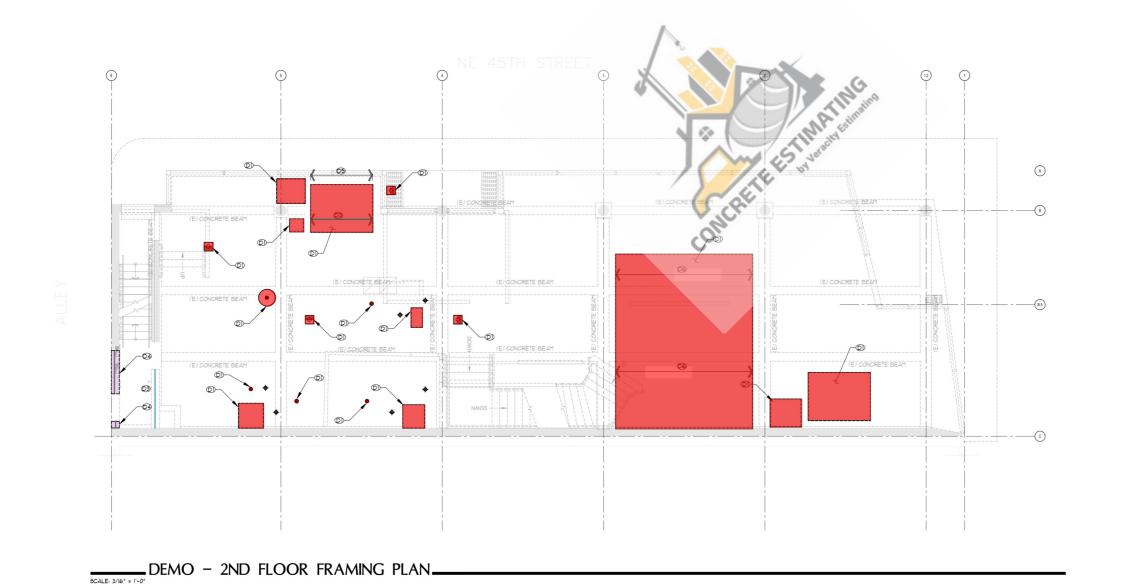
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1	12-14-2023	1st Bldg. Dept. Submittal
2	03-15-2024	2ND PERMIT SUBMITTAL
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DEMO - BASEMENT

Date:	12.14.202
Project Number:	RAC23028
Drawn By:	L.L., N.
Check By:	C.I

\$1.2

6.3 FT 14.7 FT 496.6 SQ FT



B. THESE PLANS ASSUME ALL AS BUILT DRAWINGS MATCH CURRENT CONDITIONS. IF CONDITIONS EXIST WHICH DIFFER FROM FRAMING SHOWN IT SHALL BE BROUGHT TO THE ATTENTION OF THE ENGINEER OF RECORD THROUGH THE ARCHITECT PRIOR TO DEMOL

A. VERIFY ALL DIMENSIONS, ELEVATIONS, SLOPES, ETC., w/ ARCH'L. PRIOR TO CONSTRUCTION. RESOLVE DISCREPANCIES WITH ARCHITECT.

D. PROTECT STRUCTURE FROM UNIECESSARY DAMAGE.

- E. DEMOLISH ROOF/FLOOR DECK BACK TO EXISTING FRAMING WHERE SHOWN.
- F. PLANS DENOTE DEMOLITION BELOW FRAMING LEVEL SHOWN.

DEMOLITION PLAN NOTES

LEGEND	
SYMBOL	DESCRIPTION
	EXISTING TO BE REMOVED
	EXISTING TO REMAIN
	EXISTING SLAB TO BE REMOVED
727777777777777777777	EXISTING WALL TO BE REMOVED

DEMOLITION PLAN KEYNOTES

- DEMO (E) SLAB
- (D2) NOT USED
- (E) CONCRETE BEAM
- DEMO (E) CONCRETE WALL
- (DB) DO NOT DAMAGE OR CUT (E) SLAB REBAR BEND REBAR IN (N) WALL PER DETAIL 215/552

AHJ STAMP



Raising Cane's Restaurant #C1110 4345 University Way NE. Seattle, WA 98105 Prototype NTV-B

Architectural Solutions Group

38 EXECUTIVE PARK, SUITE 310 IRVINE, CA 92614 CONTACT: JEFF LIEDERMAN (949) 430-7051 JLIEDERMAN@PMDGINC.COM



Prototype :	NTV	
Prototype Issue	Date:	-
Design Bulletin	Updates:	-
Date Issued:	Bulletin Number:	
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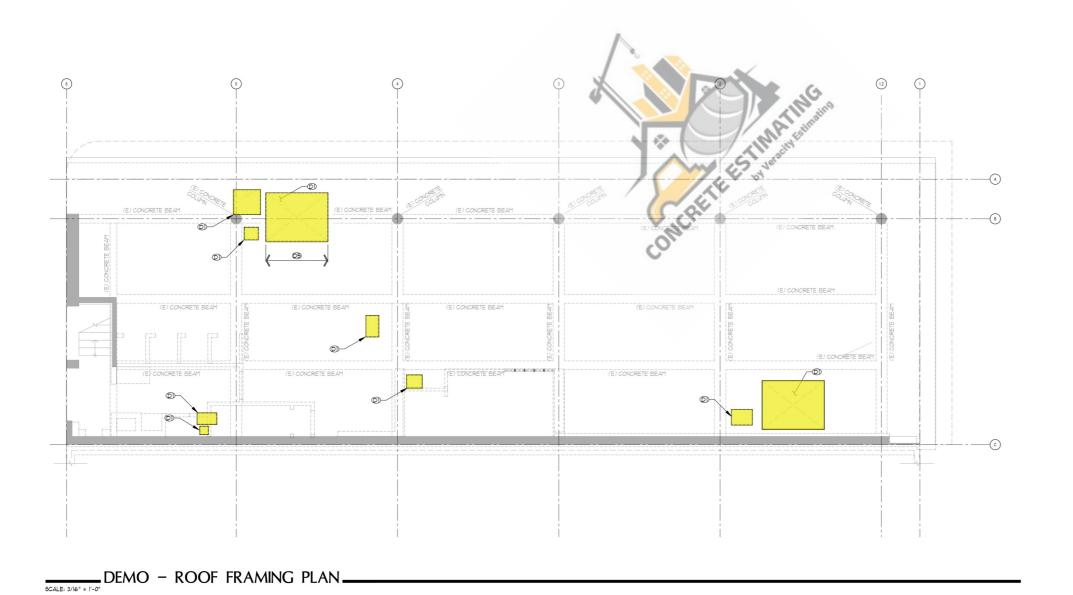
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	DATE	SUBMITTAL
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2	03-15-2024	2ND PERMIT SUBMITTAL
3	05-01-2024	2ND PERMIT RESPONSE
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DEMO - 2ND FLOOR FRAMING PLAN

Date:	12.14.202
Project Number:	RAC23028.
Drawn By:	L.L., N.F
Check By:	C.E

\$1.3

Sawcut & Remove Concrete Sl... 119.3 SQ FT



DEMOLITION PLAN NOTES

- A. VERIFY ALL DIMENSIONS, ELEVATIONS, SLOPES, ETC., w/ ARCH'L. PRIOR TO CONSTRUCTION. RESOLVE DISCREPANCIES WITH ARCHITECT.
- B. THESE PLANS ASSUME ALL AS BUILT DRAWINGS MATCH CURRENT CONDITIONS. IF CONDITIONS EXIST WHICH DIFFER FROM FRAMING SHOWN IT SHALL BE BROUGHT TO THE ATTENTION OF THE ENGINEER OF RECORD THROUGH THE ARCHITECT PRIOR TO DEMOL
- C. CONTRACTOR IS RESPONSIBLE TO SHORE AND PROTECT THE EXISTING STRUCTURE PRIOR TO DEMOLITION WORK. COORDINATE DEMOLITION OF STRUCTURAL ELEMENTS WITH THE NEW WORK REQUIRED PRIOR TO CUTTING. SHORE STRUCTURAL IMPRIBERS AS RECEIVED, INSTALL NEW STRUCTURAL ELEMENTS PRIOR TO DEMOLITION WORK WHEN POSSIBLE, SEE STRUCTURAL DRAWINGS. FIELD VERIFY ALL WORK PRIOR TO DEMOLITION.
- D. PROTECT STRUCTURE FROM UNNECESSARY DAMAGE.
- E. DEMOLISH ROOF/FLOOR DECK BACK TO EXISTING FRAMING WHERE SHOWN.

LEGEND	
SYMBOL	DESCRIPTION
	EXISTING TO BE REMOVED
	EXISTING TO REMAIN
	EXISTING SLAB TO BE REMOVED
77777777777777777777777	EXISTING WALL TO BE REMOVED

DEMOLITION PLAN KEYNOTES

- DEMO (E) SLAB
- (D2) NOT USED
- (E) CONCRETE BEAM
- (E) CONCRETE WALL
- (D) DO NOT DAMAGE OR CUT (E) SLAB REBAR BEND REBAR IN (N) WALL PER DETAIL 215/652

AHJ STAMP



Raising Cane's Restaurant #C1110 4345 University Way NE. Seattle, WA 98105 Prototype NTV-B



Solutions Group

38 EXECUTIVE PARK, SUITE 310 IRVINE, CA 92614 CONTACT: JEFF LIEDERMAN (949) 430-7051 JLIEDERMAN@PMDGINC.COM



Prototype :		NTV
Prototype Issue	Date:	-
Design Bulletin	Updates:	-
Date Issued:	Bulletin Number:	

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3	05-01-2024	2ND PERMIT RESPONSE
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DEMO - ROOF FRAMING PLAN

Project Number:	RAC23028.0
Drawn By:	L.L., N.R
Check By:	C.B

\$1.4

FOUNDATION PLAN KEYNOTES

① REFER TO DETAILS 104, 105, 108, AND 109/54.1 FOR MAT SLAB SIZE AND REINFORCING

AHJ STAMP



Raising Cane's Restaurant #C1110 4345 University Way NE. Seattle, WA 98105 Prototype NTV-B

Architectural Solutions Group

38 EXECUTIVE PARK, SUITE 310 IRVINE, CA 92614 CONTACT: JEFF LIEDERMAN (949) 430-7051 JLIEDERMAN@PMDGINC.COM



Prototype :		NTV
Prototype Issue	Date:	-
Design Bulletin	Updates:	-
Date Issued:	Bulletin Number:	
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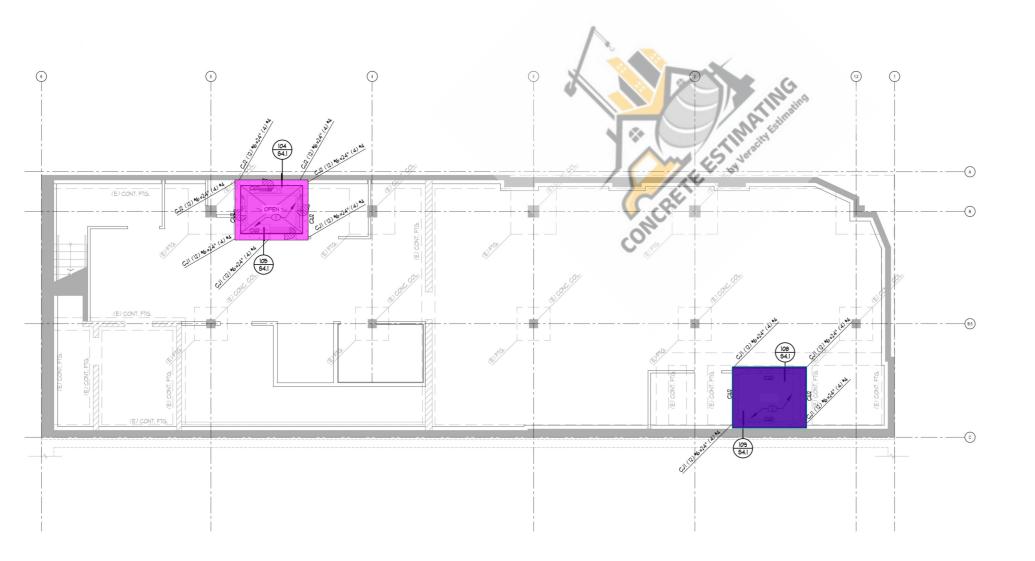
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	DATE	SUBMITTAL
1	12-14-2023	1st Bldg. Dept. Submittal
2	03-15-2024	2ND PERMIT SUBMITTAL
3	05-01-2024	2ND PERMIT RESPONSE
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FOUNDATION PLAN

Date:	12.14.2023
Project Number:	RAC23028.0
Drawn By:	L.L., N.R.
Check By:	C.B.

S2.1





SCALE: 3/16" = 1'-0" FOUNDATION PLAN


REFER TO SHEET 503 FOR PLAN NOTES AND SCHEDULE

FRAMING PLAN KEYNOTES

- (2) (N) DINING ROOM CEILING CLOUD (900 LBS), REFER TO ARCH'L DETAIL FOR ADDITIONAL INFORMATION
- 3 REFER TO ARCHITECTURAL DRAWINGS AND TYPICAL DETAIL 06/80.4 FOR SUSPENDED CEILING REQUIREMENTS

- (6) (N) MAKE-UP AIR UNIT PER MECHÁNICAL PLANS, REFER TO DETAIL 202/95,1 FOR FRAMING REQUIREMENTS UNDER UNIT

- (N) W12x22 BEAMS AT 4'-0" o.c. MAX.
- (II) HATCH INDICATES (N) CONCRETE FILLED METAL DECK PER NOTE H IN THE FRAMING PLAN NOTES

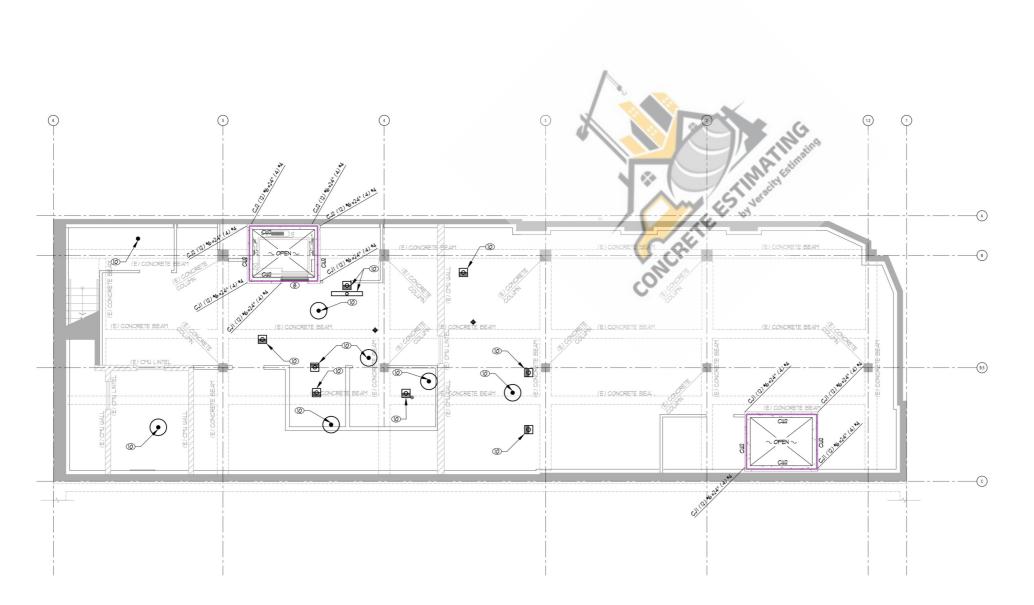

[3] (8" Thick) Reinf. Concrete Wall 9'-6"H 60.1 FT

AHJ STAMP



Raising Cane's
Restaurant #C1110
4345 University Way NE.
Seattle, WA 98105
Prototype NTV-B



38 EXECUTIVE PARK, SUITE 310 IRVINE, CA 92614 CONTACT: JEFF LIEDERMAN (949) 430-7051 JLIEDERMAN@PMDGINC.COM



Prototype :		NTV
Prototype Issue	Date:	-
Design Bulletin	Updates:	-
Date Issued:	Bulletin Number:	
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1	12-14-2023	1st Bldg. Dept. Submittal
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3	05-01-2024	2ND PERMIT RESPONSE
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	R FRAMING
Date:	12.14.2023
Project Number:	RAC23028.0
Drawn By:	L.L., N.R.
Check By:	C.B.
Sheet Number:	12.14.2023 RAC23028.0 LL., NR.

SCALE: 3/16" = 1'-0" BASEMENT FRAMING PLAN -

REFER TO SHEET 503 FOR PLAN NOTES AND SCHEDULE


- (2) (N) DINING ROOM CEILING CLOUD (900 LBS), REFER TO ARCH'L DETAIL FOR ADDITIONAL INFORMATION
- 3 REFER TO ARCHITECTURAL DRAWINGS AND TYPICAL DETAIL 06/80.4 FOR SUSPENDED CEILING REQUIREMENTS

- (6) (N) MAKE-UP AIR UNIT PER MECHANICAL PLANS, REFER TO DETAIL 202/95,1 FOR FRAMING REQUIREMENTS UNDER UNIT

FRAMING PLAN KEYNOTES

- (9) (N) W12x22 BEAMS AT 4'-0" o.c. MAX.
- (II) HATCH INDICATES (N) CONCRETE FILLED METAL DECK PER NOTE H IN THE FRAMING PLAN NOTES

[3] (8" Thick) Reinf. Concrete Wall 12'29.9 FT

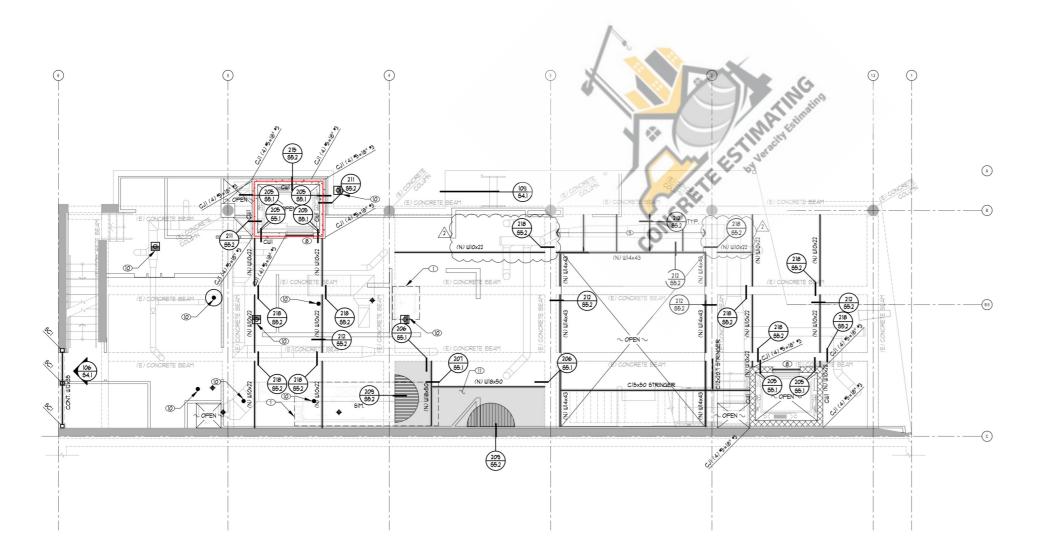

AHJ STAMP



Raising Cane's Restaurant #C1110 4345 University Way NE. Seattle, WA 98105 Prototype NTV-B



38 EXECUTIVE PARK, SUITE 310 IRVINE, CA 92614 CONTACT: JEFF LIEDERMAN (949) 430-7051 JLIEDERMAN@PMDGINC.COM



Prototype :	NTV	
Prototype Issue Date:		-
Design Bulletin Updates:		-
Date Issued:	Bulletin Number:	
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2	03-15-2024	2ND PERMIT SUBMITTAL
3	05-01-2024	2ND PERMIT RESPONSE
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2ND FLOOR FRAMING PLAN

Date:	12.14.202
Project Number:	RAC23028.
Drawn By:	L.L., N.F
Check By:	C.F

S2.3


SCALE: 3/16" = 1'-0" 2ND FLOOR FRAMING PLAN

REFER TO SHEET 503 FOR PLAN NOTES AND SCHEDULE

FRAMING PLAN KEYNOTES

- (2) (N) DINING ROOM CEILING CLOUD (900 LB6), REFER TO ARCH'L DETAIL FOR ADDITIONAL INFORMATION
- 3 REFER TO ARCHITECTURAL DRAWINGS AND TYPICAL DETAIL 06/80.4 FOR SUSPENDED CEILING REQUIREMENTS

- (6) (N) MAKE-UP AIR UNIT PER MECHANICAL PLANS, REFER TO DETAIL 202/95,1 FOR FRAMING REQUIREMENTS UNDER UNIT
- CONCRETE LINTEL PER DETAIL 01/90.4
- (N) W12x22 BEAMS AT 4'-0" o.c. MAX.
- (II) HATCH INDICATES (N) CONCRETE FILLED METAL DECK PER NOTE H IN THE FRAMING PLAN NOTES

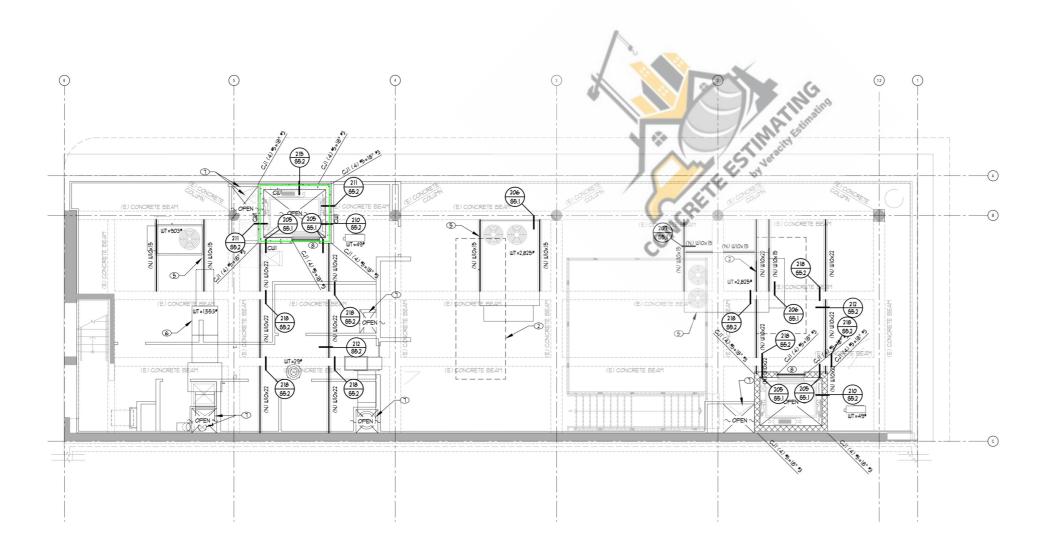

30.4 FT

[3] (8" Thick) Reinf. Concrete Wall 4'H

AHJ STAMP



Raising Cane's Restaurant #C1110 4345 University Way NE. Seattle, WA 98105 Prototype NTV-B



38 EXECUTIVE PARK, SUITE 310 IRVINE, CA 92614 CONTACT: JEFF LIEDERMAN (949) 430-7051 JLIEDERMAN@PMDGINC.COM



Prototype : Prototype Issue Date: Design Bulletin Updates:		NTV	
Date Issued:	Bulletin Number:		

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R	EVISIONS:	
	DATE	SUBMITTAL
1	12-14-2023	1st Bldg. Dept. Submittal
2	03-15-2024	2ND PERMIT SUBMITTAL
3	05-01-2024	2ND PERMIT RESPONSE
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ROOF FRAMING PLAN

Date:	12.14.2023
Project Number:	RAC23028.0
Drawn By:	L.L., N.R.
Check By:	CB

S2.4